


SITE PLAN FOR MEADOWBROOK COUNTRY CLUB DRIVING RANGE AND PARKING LOT NORTHVILLE TOWNSHIP, MICHIGAN

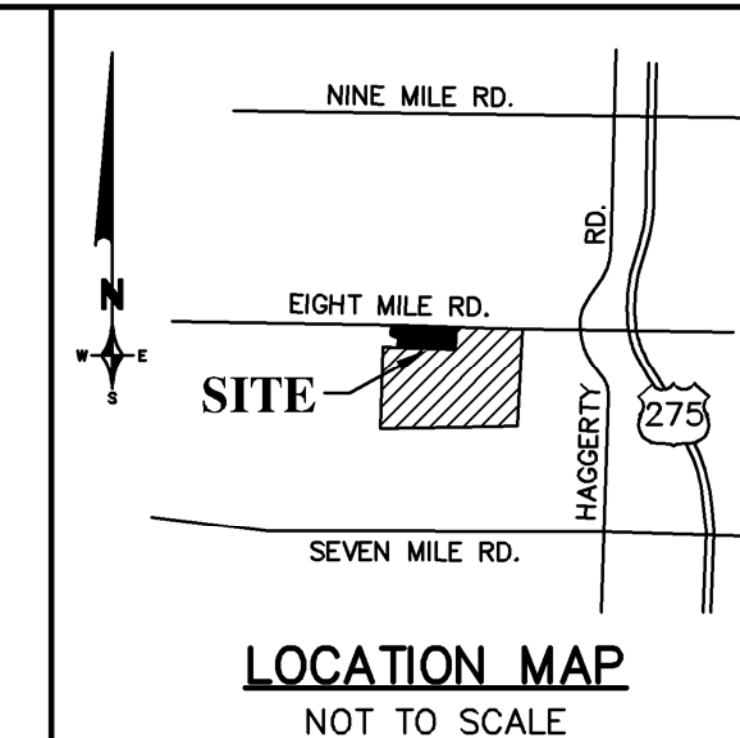


OWNER:
MEADOWBROOK COUNTRY CLUB
40941 W. EIGHT MILE ROAD
NORTHVILLE TOWNSHIP, MI 48167
PHONE: (734) 427-9111
CONTACT: JOE ARISTEO, REPRESENTATIVE

CIVIL ENGINEER/LAND SURVEYOR:
ZEIMET WOZNAK AND ASSOCIATES, INC.
55800 GRAND RIVER, SUITE 100
NEW HUDSON, MI 48165
PHONE: (248) 437-5099 FAX: (248) 437-5222
CONTACT: ANDY WOZNAK

LANDSCAPE ARCHITECT:
ALLEN DESIGN
3557 CARPENTER
NORTHVILLE, MI 48167
PHONE: (248) 467-4668
CONTACT: JIM ALLEN, RLA

GOLF COURSE ARCHITECT:
STAPLES GOLF DESIGN
4300 MILLER ROAD, SUITE 124
SCOTTSDALE, AZ 85251
PHONE: (602) 843-9074
CONTACT: ANDY STAPLES

ARCHITECT:
MCINTOSH PORIS ASSOCIATES
36801 WOODWARD AVE., SUITE 200
BIRMINGHAM, MI 48009
PHONE: (248) 258-9346
CONTACT: ROSS HOEKSTRA

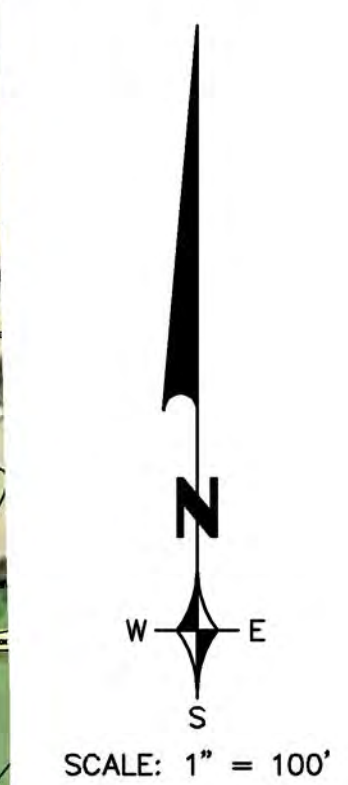

SHEET INDEX:

C-000	COVER
ENGINEERING	
C-100	OVERALL EXISTING CONDITIONS
C-101	EXISTING CONDITIONS
C-102	EXISTING CONDITIONS
C-103	EXISTING CONDITIONS
C-104	EXISTING CONDITIONS
C-200	OVERALL PAVING AND DIMENSIONS
C-201	PAVING AND DIMENSIONS
C-202	PAVING AND DIMENSIONS
C-203	PAVING AND DIMENSIONS
C-204	PAVING AND DIMENSIONS
C-300	OVERALL SITE PREPARATIONS
C-301	SITE PREPARATIONS
C-302	SITE PREPARATIONS
C-303	SITE PREPARATIONS
C-304	SITE PREPARATIONS
C-400	OVERALL GRADING AND DRAINAGE
C-401	GRADING AND DRAINAGE
C-402	GRADING AND DRAINAGE
C-403	GRADING AND DRAINAGE
C-404	GRADING AND DRAINAGE
C-500	OVERALL STORM SEWER
C-501	STORM SEWER
C-502	STORM SEWER
C-503	STORM SEWER
C-504	STORM SEWER
C-600	OVERALL SANITARY SEWER AND WATERMAIN
C-601	SANITARY SEWER AND WATERMAIN
C-602	SANITARY SEWER AND WATERMAIN
C-603	SANITARY SEWER AND WATERMAIN
C-604	SANITARY SEWER AND WATERMAIN
C-605	HYDRANT COVERAGE PLAN
C-700	OVERALL EROSION CONTROL
C-701	EROSION CONTROL
C-702	EROSION CONTROL
C-703	EROSION CONTROL
C-704	EROSION CONTROL
C-800	STORMWATER MANAGEMENT CALCULATIONS & DETAILS
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LANDSCAPING	
L-1	EXISTING ENTRY VEGETATION
L-2	ENTRY PLAN
L-3	LANDSCAPE PLAN
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A-201	EXTERIOR ELEVATIONS
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E-003	ELECTRICAL SITE PLAN
E-004	ELECTRICAL CUT SHEETS
E-201	LEVEL 1 LIGHTING PLAN
L-201	SITE LIGHTING CALCULATIONS



MEADOWBROOK COUNTRY CLUB LEGAL DESCRIPTION
PART OF THE NORTH 1/2 OF SECTION 1, T. 1 S., R. 8 E., NORTHVILLE TOWNSHIP, WAYNE COUNTY, MICHIGAN, BEING MORE PARTICULARLY DESCRIBED AS:

COMMENCING AT THE NORTHWEST CORNER OF SAID SECTION 1 AND PROCEEDING ALONG THE NORTH LINE OF SECTION 1 ALSO BEING THE CENTERLINE OF EIGHT MILE ROAD (60 FEET WIDE, 1/2 WIDTH) N. 87°00'02" E. 178.75 FEET; THENCE S. 02°46'25" E. 60.00 FEET TO THE POINT OF BEGINNING LOCATED ON THE SOUTH RIGHT-OF-WAY LINE OF EIGHT MILE ROAD; THENCE FROM SAID POINT OF BEGINNING AND ALONG SAID SOUTH RIGHT-OF-WAY LINE OF EIGHT MILE ROAD THE FOLLOWING TWO (2) COURSES: 1.) N. 87°00'02" E. 2494.39 FEET AND 2.) N. 86°43'12" E. 696.39 FEET TO THE WEST LINE OF "SPRINGBROOK HILLS TRACT NO. ONE", ALSO BEING THE WEST LINE OF SPRING STREET (25 FEET WDE), ALL BEING RECORDED IN LIBER 35, PAGE 8 WAYNE COUNTY RECORDS; THENCE ALONG SAID WEST LINE, S. 01°57'05" E. 1539.62 FEET MEASURED, (PREVIOUSLY RECORDED AS S. 01°45' W. 1540.00 FEET); THENCE ALONG THE WEST LINE OF "FAIRWAYS OF MEADOWBROOK SUBDIVISION", RECORDED IN LIBER 117, PAGES 34-36 INCLUSIVE WAYNE COUNTY RECORDS, S. 01°44'54" E. 834.43 FEET (PREVIOUSLY RECORDED AS S. 02°34'40" W.) TO THE NORTH LINE OF "MEADOWBROOK ESTATES", AS RECORDED IN LIBER 43, PAGE 97 WAYNE COUNTY RECORDS, ALSO BEING ALONG THE EAST AND WEST 1/4 LINE OF SAID SECTION 1; THENCE ALONG SAID NORTH LINE OF "MEADOWBROOK ESTATES", S. 84°10'04" W. 658.45 FEET (PREVIOUSLY RECORDED AS S. 87°48' W.) TO THE CENTER OF SAID SECTION 1; THENCE CONTINUING ALONG SAID EAST AND WEST 1/4 LINE TO THE FOLLOWING TWO (2) COURSES: 1.) S. 84°07'06" W. 815.50 FEET AND 2.) ALONG THE NORTH LINE OF "GRAND VIEW ACRES", RECORDED IN LIBER 51, PAGE 13 WAYNE COUNTY RECORDS, S. 84°04'37" W. 1863.46 FEET (PREVIOUSLY RECORDED AS S. 86°55'40" W. 1863.15 FEET) TO THE WEST 1/4 CORNER OF SAID SECTION 1; THENCE ALONG THE WEST LINE OF SECTION 1, ALSO BEING THE EAST LINE OF "QUAIL RIDGE SUBDIVISION" RECORDED IN LIBER 99, PAGES 29-31 INCLUSIVE, WAYNE COUNTY RECORDS, N. 02°46'25" W. 1998.80 FEET (PREVIOUSLY RECORDED AS N. 02°47'10" W.); THENCE N. 87°00'02" E. 357.50 FEET; THENCE N. 02°46'25" W. 208.50 FEET; THENCE N. 67°55'17" W. 196.99 FEET MEASURED (197.18 FEET RECORD); THENCE N. 02°46'25" W. 248.00 FEET (MEASURED AND RECORD) TO THE POINT OF BEGINNING, CONTAINING 185.59 ACRES OF LAND MORE OR LESS.


GENERAL PROVISIONS:

- THE LOCATIONS OF EXISTING UNDERGROUND UTILITIES ARE SHOWN IN AN APPROXIMATE WAY ONLY AS DISCLOSED BY AVAILABLE UTILITY COMPANY RECORDS AND HAVE NOT BEEN INDEPENDENTLY VERIFIED BY THE COMPANY. NO GUARANTEE IS EITHER EXPRESSED OR IMPLIED AS TO THE COMPLETENESS OR ACCURACY THEREOF. THE CONTRACTOR SHALL DETERMINE THE EXACT LOCATION OF ALL EXISTING UTILITIES BEFORE COMMENCING WORK, AND AGREES TO BE FULLY RESPONSIBLE FOR ANY AND ALL DAMAGES WHICH MIGHT BE OCCASIONED BY THE CONTRACTOR'S FAILURE TO EXACTLY LOCATE AND PRESERVE ANY AND ALL UNDERGROUND UTILITIES. THE CONTRACTOR SHALL NOTIFY THE DESIGN ENGINEER IMMEDIATELY IF A CONFLICT IS APPARENT.
- THE CONTRACTOR SHALL BE RESPONSIBLE FOR ADJUSTMENT OF ALL STRUCTURES, KNOWN OR UNKNOWN, SHOWN OR UNSHOWN, LOCATED WITHIN THE LIMITS OF CONSTRUCTION. THE CONTRACTOR SHALL NOTIFY THE OWNER OR OWNER'S REPRESENTATIVE IF ANY SUCH STRUCTURES ARE IDENTIFIED. ALL COSTS ASSOCIATED WITH LOCATING AND ADJUSTING THESE STRUCTURES SHALL BE THE RESPONSIBILITY OF THE CONTRACTOR.
- DESIGN PROFESSIONAL AND CLIENT WARRANT THAT IN TRANSMITTING INSTRUMENTS OF SERVICE, OR ANY OTHER INFORMATION, THE TRANSMITTING PARTY IS THE COPYRIGHT OWNER OF SUCH INFORMATION OR HAS PERMISSION FROM THE COPYRIGHT OWNER TO TRANSIT SUCH INFORMATION FOR ITS USE OF THE PROJECT. IF THE CLIENT AND DESIGN PROFESSIONAL INTEND TO TRANSMIT INSTRUMENTS OF SERVICE OR ANY OTHER INFORMATION OR DOCUMENTATION IN DIGITAL FORM, THEY SHALL ENDEAVOR TO ESTABLISH NECESSARY PROTOCOLS GOVERNING SUCH TRANSMISSIONS.

DATE	ISSUED FOR
5/4/22	DD REVIEW
6/15/22	SP SUBMITTAL
PROJECT SPONSOR: MEADOWBROOK COUNTRY CLUB 40941 W. EIGHT MILE ROAD NORTHVILLE TWP., MI 48167	
PROJECT NO. C-000 COVER DRIVING RANGE AND PARKING LOT NORTHVILLE TOWNSHIP MICHIGAN	
SCALE	DATE
HOR: 1" = 60'	5/15-22
VER: 1" = N/A	REVISION
JOB NO. 20163	DATE
SHEET NO. C-000	DATE
	DATE

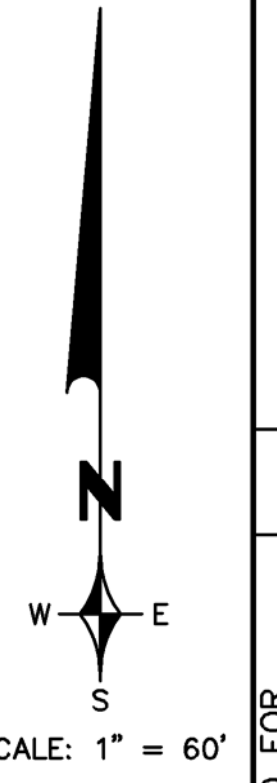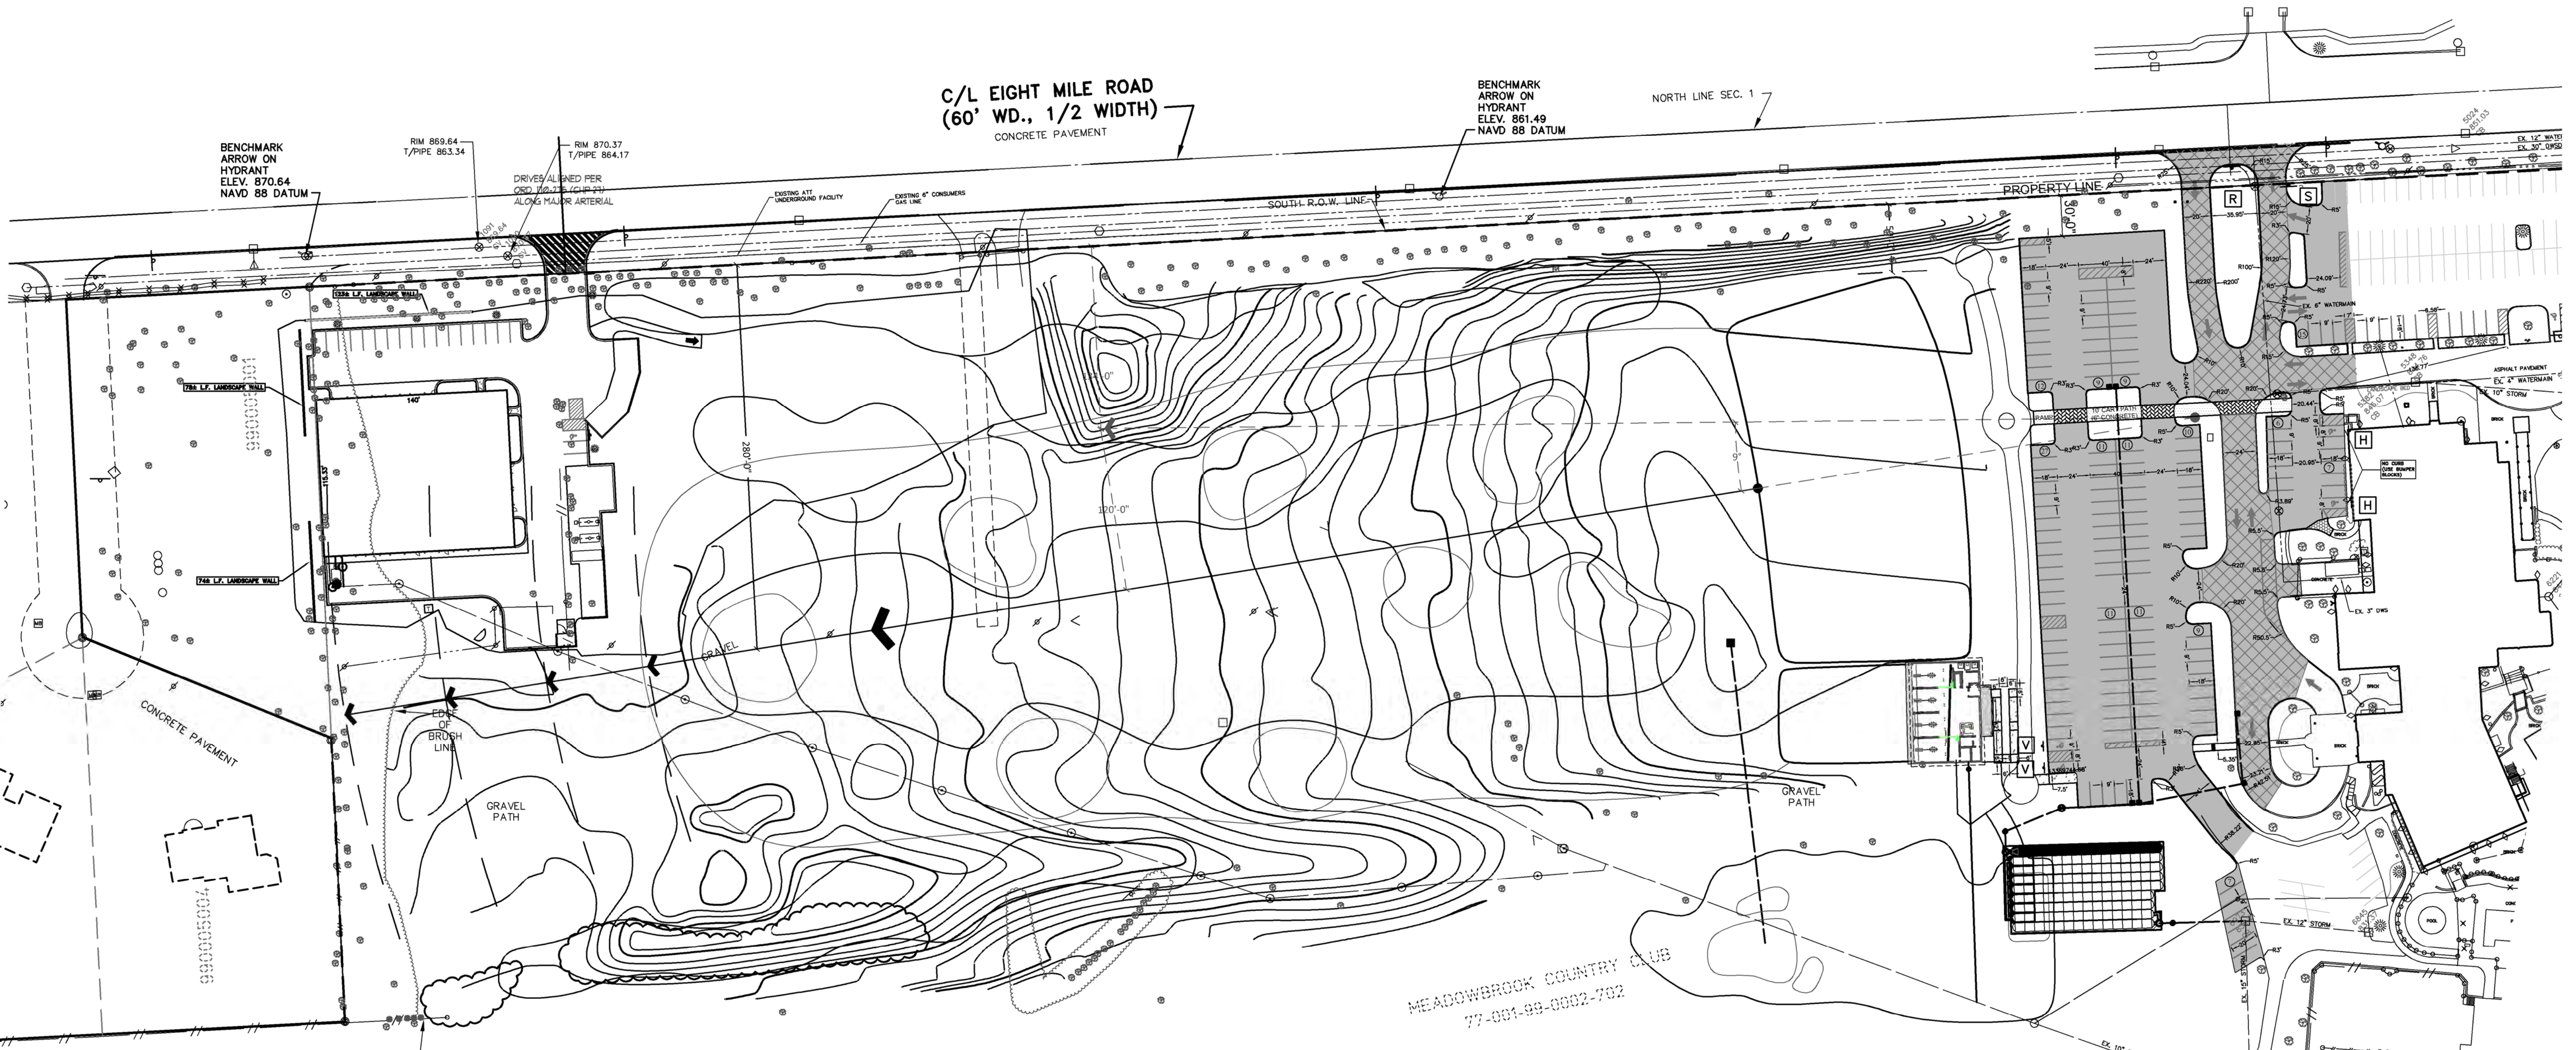


- NOTES:**
- THE LOCATIONS OF EXISTING UNDERGROUND UTILITIES ARE SHOWN IN AN APPROXIMATE WAY ONLY AS DISCLOSED BY AVAILABLE UTILITY COMPANY RECORDS AND HAVE NOT BEEN INDEPENDENTLY VERIFIED BY THE COMPANY. NO GUARANTEE IS EITHER EXPRESSED OR IMPLIED AS TO THE COMPLETENESS OR ACCURACY THEREOF. THE CONTRACTOR SHALL DETERMINE THE EXACT LOCATION OF ALL EXISTING UTILITIES BEFORE COMMENCING WORK, AND AGREES TO BE FULLY RESPONSIBLE FOR ANY AND ALL DAMAGES WHICH MIGHT BE OCCASIONED BY THE CONTRACTOR'S FAILURE TO EXACTLY LOCATE AND PRESERVE ANY AND ALL UNDERGROUND UTILITIES. THE CONTRACTOR SHALL NOTIFY THE DESIGN ENGINEER IMMEDIATELY IF A CONFLICT IS APPARENT.
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 - DESIGN PROFESSIONAL AND CLIENT WARRANT THAT IN TRANSMITTING INSTRUMENTS OF SERVICE, OR ANY OTHER INFORMATION, THE TRANSMITTING PARTY IS THE COPYRIGHT OWNER OF SUCH INFORMATION OR HAS PERMISSION FROM THE COPYRIGHT OWNER TO TRANSMIT SUCH INFORMATION FOR ITS USE OF THE PROJECT. IF THE CLIENT AND DESIGN PROFESSIONAL INTEND TO TRANSMIT INSTRUMENTS OF SERVICE OR ANY OTHER INFORMATION OR DOCUMENTATION IN DIGITAL FORM, THEY SHALL ENDEAVOR TO ESTABLISH NECESSARY PROTOCOLS GOVERNING SUCH TRANSMISSIONS.

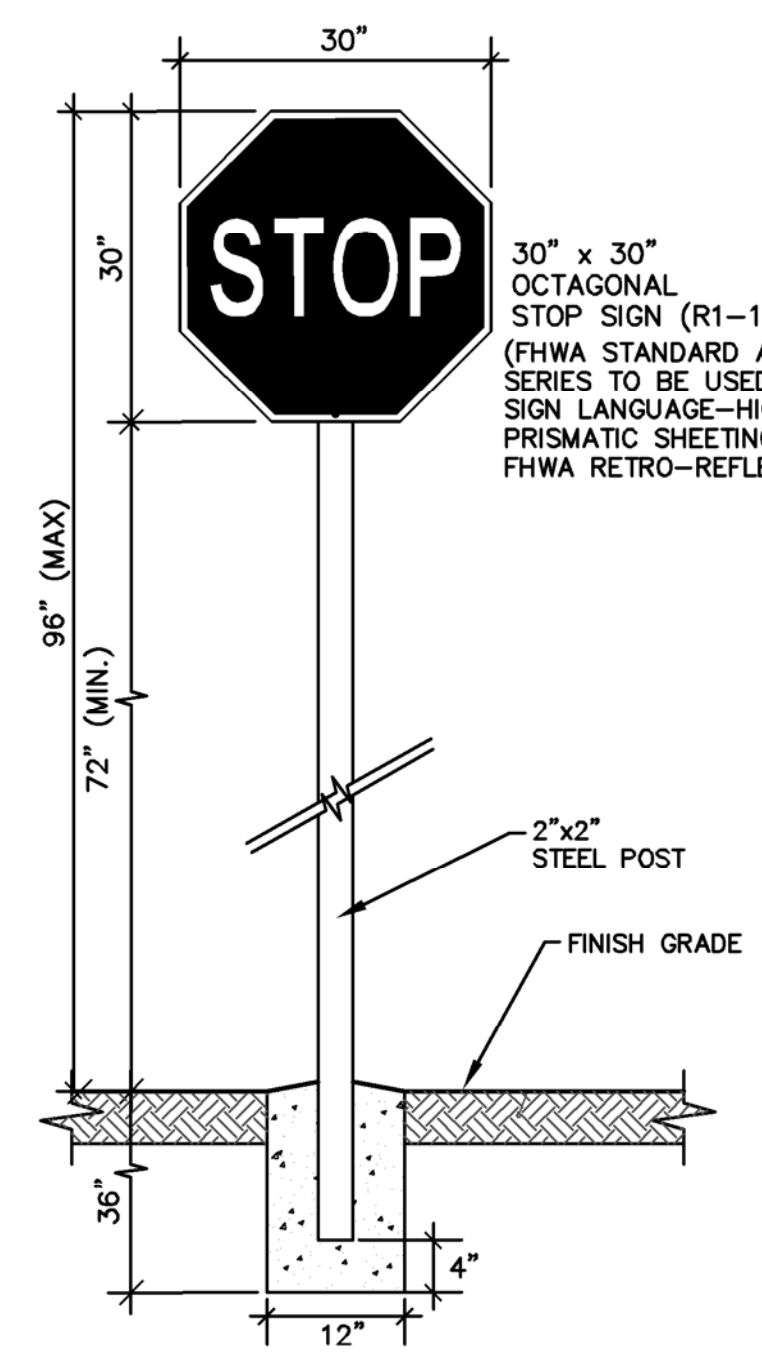

R1-1 STOP SIGN DETAIL
NOT TO SCALE

* TO BE PLACED 2' FROM BACK OF WALK / CURB

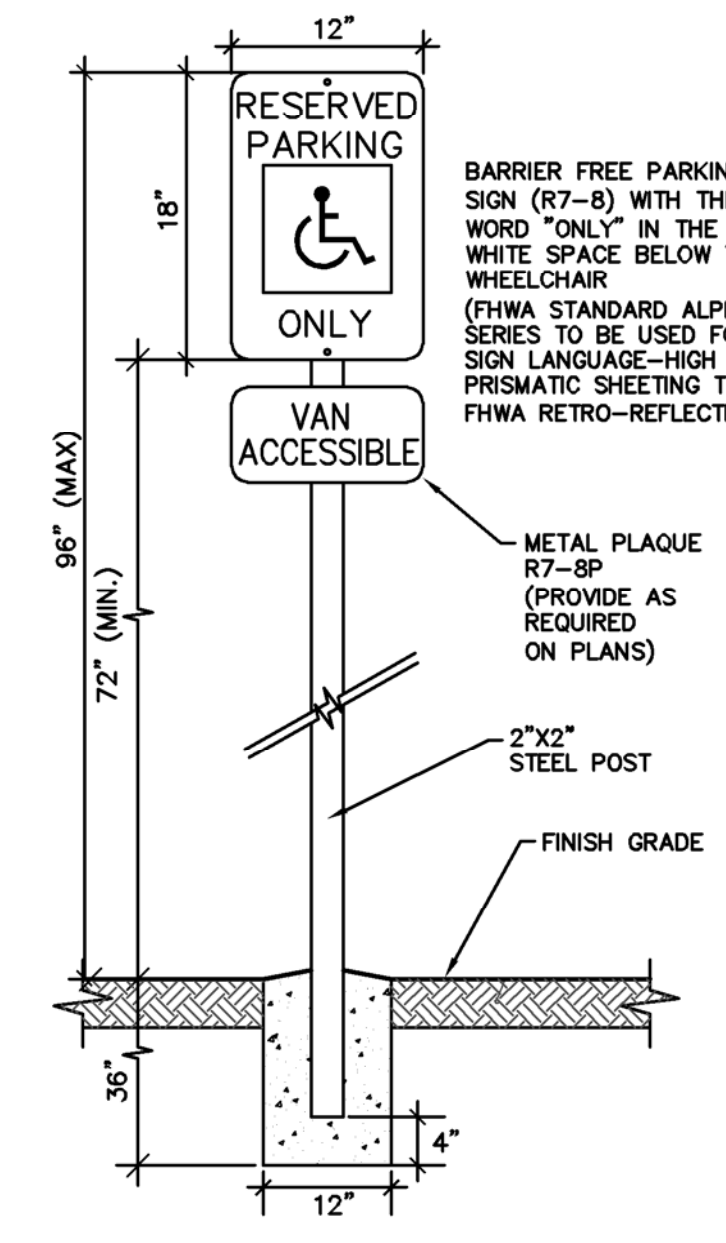

R7-8 BARRIER FREE PARKING SIGN DETAIL
NOT TO SCALE

* TO BE PLACED 2' BACK OF WALK / CURB

PAVEMENT CONSTRUCTION NOTES:

- IN GENERAL, ALL EARTHWORK AND PAVEMENT CONSTRUCTION SHOULD BE PERFORMED IN ACCORDANCE WITH THE CURRENT M.DOT STANDARD SPECIFICATIONS FOR CONSTRUCTION UNLESS OTHERWISE NOTED IN THE FOLLOWING ITEMS.
- CONSTRUCTION SHOULD TAKE PLACE DURING THE SUMMER MONTHS OF JUNE THROUGH SEPTEMBER. DRIER WEATHER CONDITIONS ARE PREFERRED TO ALLOW FOR MORE EFFICIENT PREPARATION OF THE SUBGRADE SOILS AND INSTALLATION OF THE PAVEMENT LAYERS.
- REMOVE THE EXISTING PAVEMENT STRUCTURE, EXISTING TOPSOIL, ORGANIC SOILS, UNSUITABLE FILL, VEGETATION, TREES, AND OTHER DELETERIOUS MATERIALS TO EXPOSE THE SUBGRADE SOIL. TREE ROOTS SHOULD BE COMPLETELY REMOVED. EXISTING STRUCTURES SHOULD BE REMOVED AND REPLACED WITH ENGINEERED FILL A MINIMUM OF 3 FEET BELOW THE PROPOSED PAVEMENT LAYER TO PROVIDE A UNIFORM SUBGRADE.
- EXCAVATE TO THE DEPTH OF THE FINAL SUBGRADE ELEVATION TO ALLOW FOR GRADE CHANGES AND THE PLACEMENT OF THE RECOMMENDED PAVEMENT SYSTEM.
- PERFORM TEST PITS AS DIRECTED BY THE OWNER'S REPRESENTATIVE ALONG THE NORTH SLOPE OF THE DETENTION BASIN TO DELINEATE PEAT SOILS. UNDERCUT AND BACKFILL ENCOUNTERED PEAT SOILS AS DIRECTED BY THE OWNER'S REPRESENTATIVE.
- THE TOP 12 INCHES OF THE EXPOSED SUBGRADE AS WELL AS INDIVIDUAL FILL LAYERS SHOULD BE COMPACTED TO ACHIEVE A MINIMUM OF 95 PERCENT OF THE MAXIMUM MODIFIED PROCTOR DRY DENSITY. MANIPULATE THE MOISTURE CONTENT TO WITHIN 2 PERCENTAGE POINTS OF THE OPTIMUM MOISTURE.
- THE FINAL SUBGRADE SHOULD BE THOROUGHLY PROOF ROLLED USING A LOADED TANDEM AXLE TRUCK UNDER THE OBSERVATION OF THE GEOTECHNICAL ENGINEER. LOOSE OR YIELDING AREAS THAT CAN NOT BE MECHANICALLY STABILIZED SHOULD BE REMOVED AND REPLACED WITH ENGINEERED FILL OR AS DICTATED BY THE FILED CONDITIONS.
- THE AGGREGATE BASE SHOULD BE COMPACTED TO ACHIEVE A MINIMUM OF 95 PERCENT OF THE MAXIMUM MODIFIED PROCTOR DRY DENSITY. THE BASE AND SUBGRADE COMPACTION SHOULD EXTEND A MINIMUM OF 12 INCHES BEYOND THE PAVED EDGE OF BACK OF CURB.
- FINAL PAVEMENT ELEVATIONS SHOULD PROVIDE POSITIVE SURFACE DRAINAGE.
- STRIPES PARKING LOT IN ACCORDANCE WITH CURRENT TOWNSHIP STANDARDS.

SIGN LEGEND:

- [S] 30"x30" STOP (R1-1) - 1 TOTAL
- [H] 12"x18" BARRIER FREE PARKING (R7-8) - 2 TOTAL
- [V] 12"x18" BARRIER FREE PARKING (R7-8) WITH 12"x36" VAN ACCESSIBLE (PLAQUE) (R7-8P) - 2 TOTAL
- [R] 24"x30" KEEP RIGHT (R4-7) - 1 TOTAL


ALL SIGN SHALL CONFORM TO CURRENT MUTCD STANDARDS.

PAVEMENT SECTIONS:

- HEAVY DUTY ASPHALT:
1.5" 5E1 WEARING COURSE ON
2.5" 3C LEVELING COURSE ON
10.0" MDOT 21AA AGGREGATED BASE ON
PREPARED SUBGRADE
- REGULAR DUTY ASPHALT:
1.5" 5E1 WEARING COURSE ON
1.5" 3C LEVELING COURSE ON
8.0" MDOT 21AA AGGREGATE BASE ON
PREPARED SUBGRADE
- CONCRETE CART PATH:
6.0" UNIFORM MDOT P1 MIX (4000 PSI) ON
4.0" MDOT 21AA AGGREGATE BASE ON
PREPARED SUBGRADE
- BRICK CART PATH:
BRICK PAVER (PER OWNER) ON
SLAG SAND SETTING BED ON
6.0" REINFORCED CONCRETE (4000 PSI) ON
6.0" MDOT CLASS 2 SAND BASE ON
PREPARED SUBGRADE
- CONCRETE SIDEWALK:
4.0" UNIFORM MDOT P1 MIX (4000 PSI) ON
4.0" MDOT CLASS 2 SAND BASE ON
PREPARED SUBGRADE


- NOTES:**
- PAVEMENT SECTIONS ARE SUBJECT TO THE RECOMMENDATION OF THE GEOTECHNICAL ENGINEER.
 - SUBGRADE TO BE PREPARED IN ACCORDANCE WITH GEOTECHNICAL ENGINEER'S RECOMMENDATIONS.
 - BASE MATERIAL TO BE COMPACTED TO MIN. 95% MAXIMUM UNIT DENSITY.
 - ALL PAVEMENT WITHIN THE 8 MILE ROAD RIGHT-OF-WAY SHALL CONFORM TO THE CURRENT WAYNE COUNTY STANDARDS (PERMIT REQUIRED).

NOTE: ALL DIMENSIONS SHOWN ARE TO FACE OF CURB, EDGE OF WALK, OR FACE OF BUILDING UNLESS OTHERWISE NOTED.

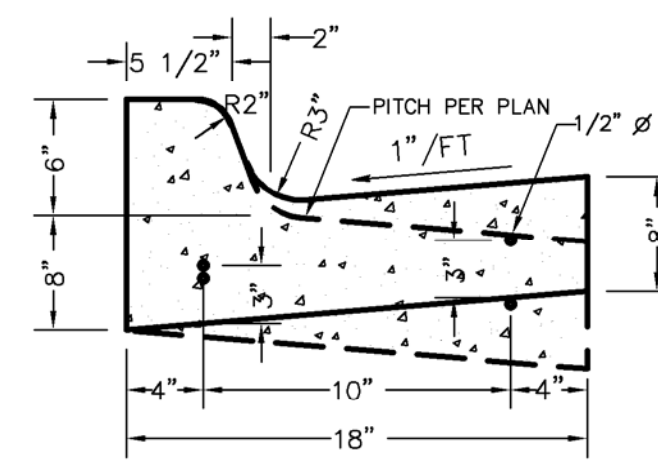

6" CURB & GUTTER
CURB DETAILS
NOT TO SCALE

Z EIMET WOZNAK & ASSOCIATES Civil Engineers & Land Surveyors 5000 WOODLAND AVE., SUITE 100 NORTHVILLE, MI 48901 P: (248) 437-5000 F: (248) 437-5222 www.zimewozna.com	
PROJECT SPONSOR: MEADOWBROOK COUNTRY CLUB 40941 W. EIGHT MILE ROAD NORTHVILLE TWP., MI 48167	ISSUED FOR: DD REVIEW SP SUBMITTAL
DATE: 5/4/22 6/15/22	DATE: DD REVIEW SP SUBMITTAL
OVERALL PAVING AND DIMENSIONS DRIVING RANGE AND PARKING LOT NORTHVILLE TOWNSHIP MICHIGAN	
SCALE: HOR: 1" = 60' VER: 1" = 10' JOB NO. 20163	FIELD BOOK: DATE: 5-22 DRAWN BY: JAW CHECKED BY: JAW SHEET NO. C-200

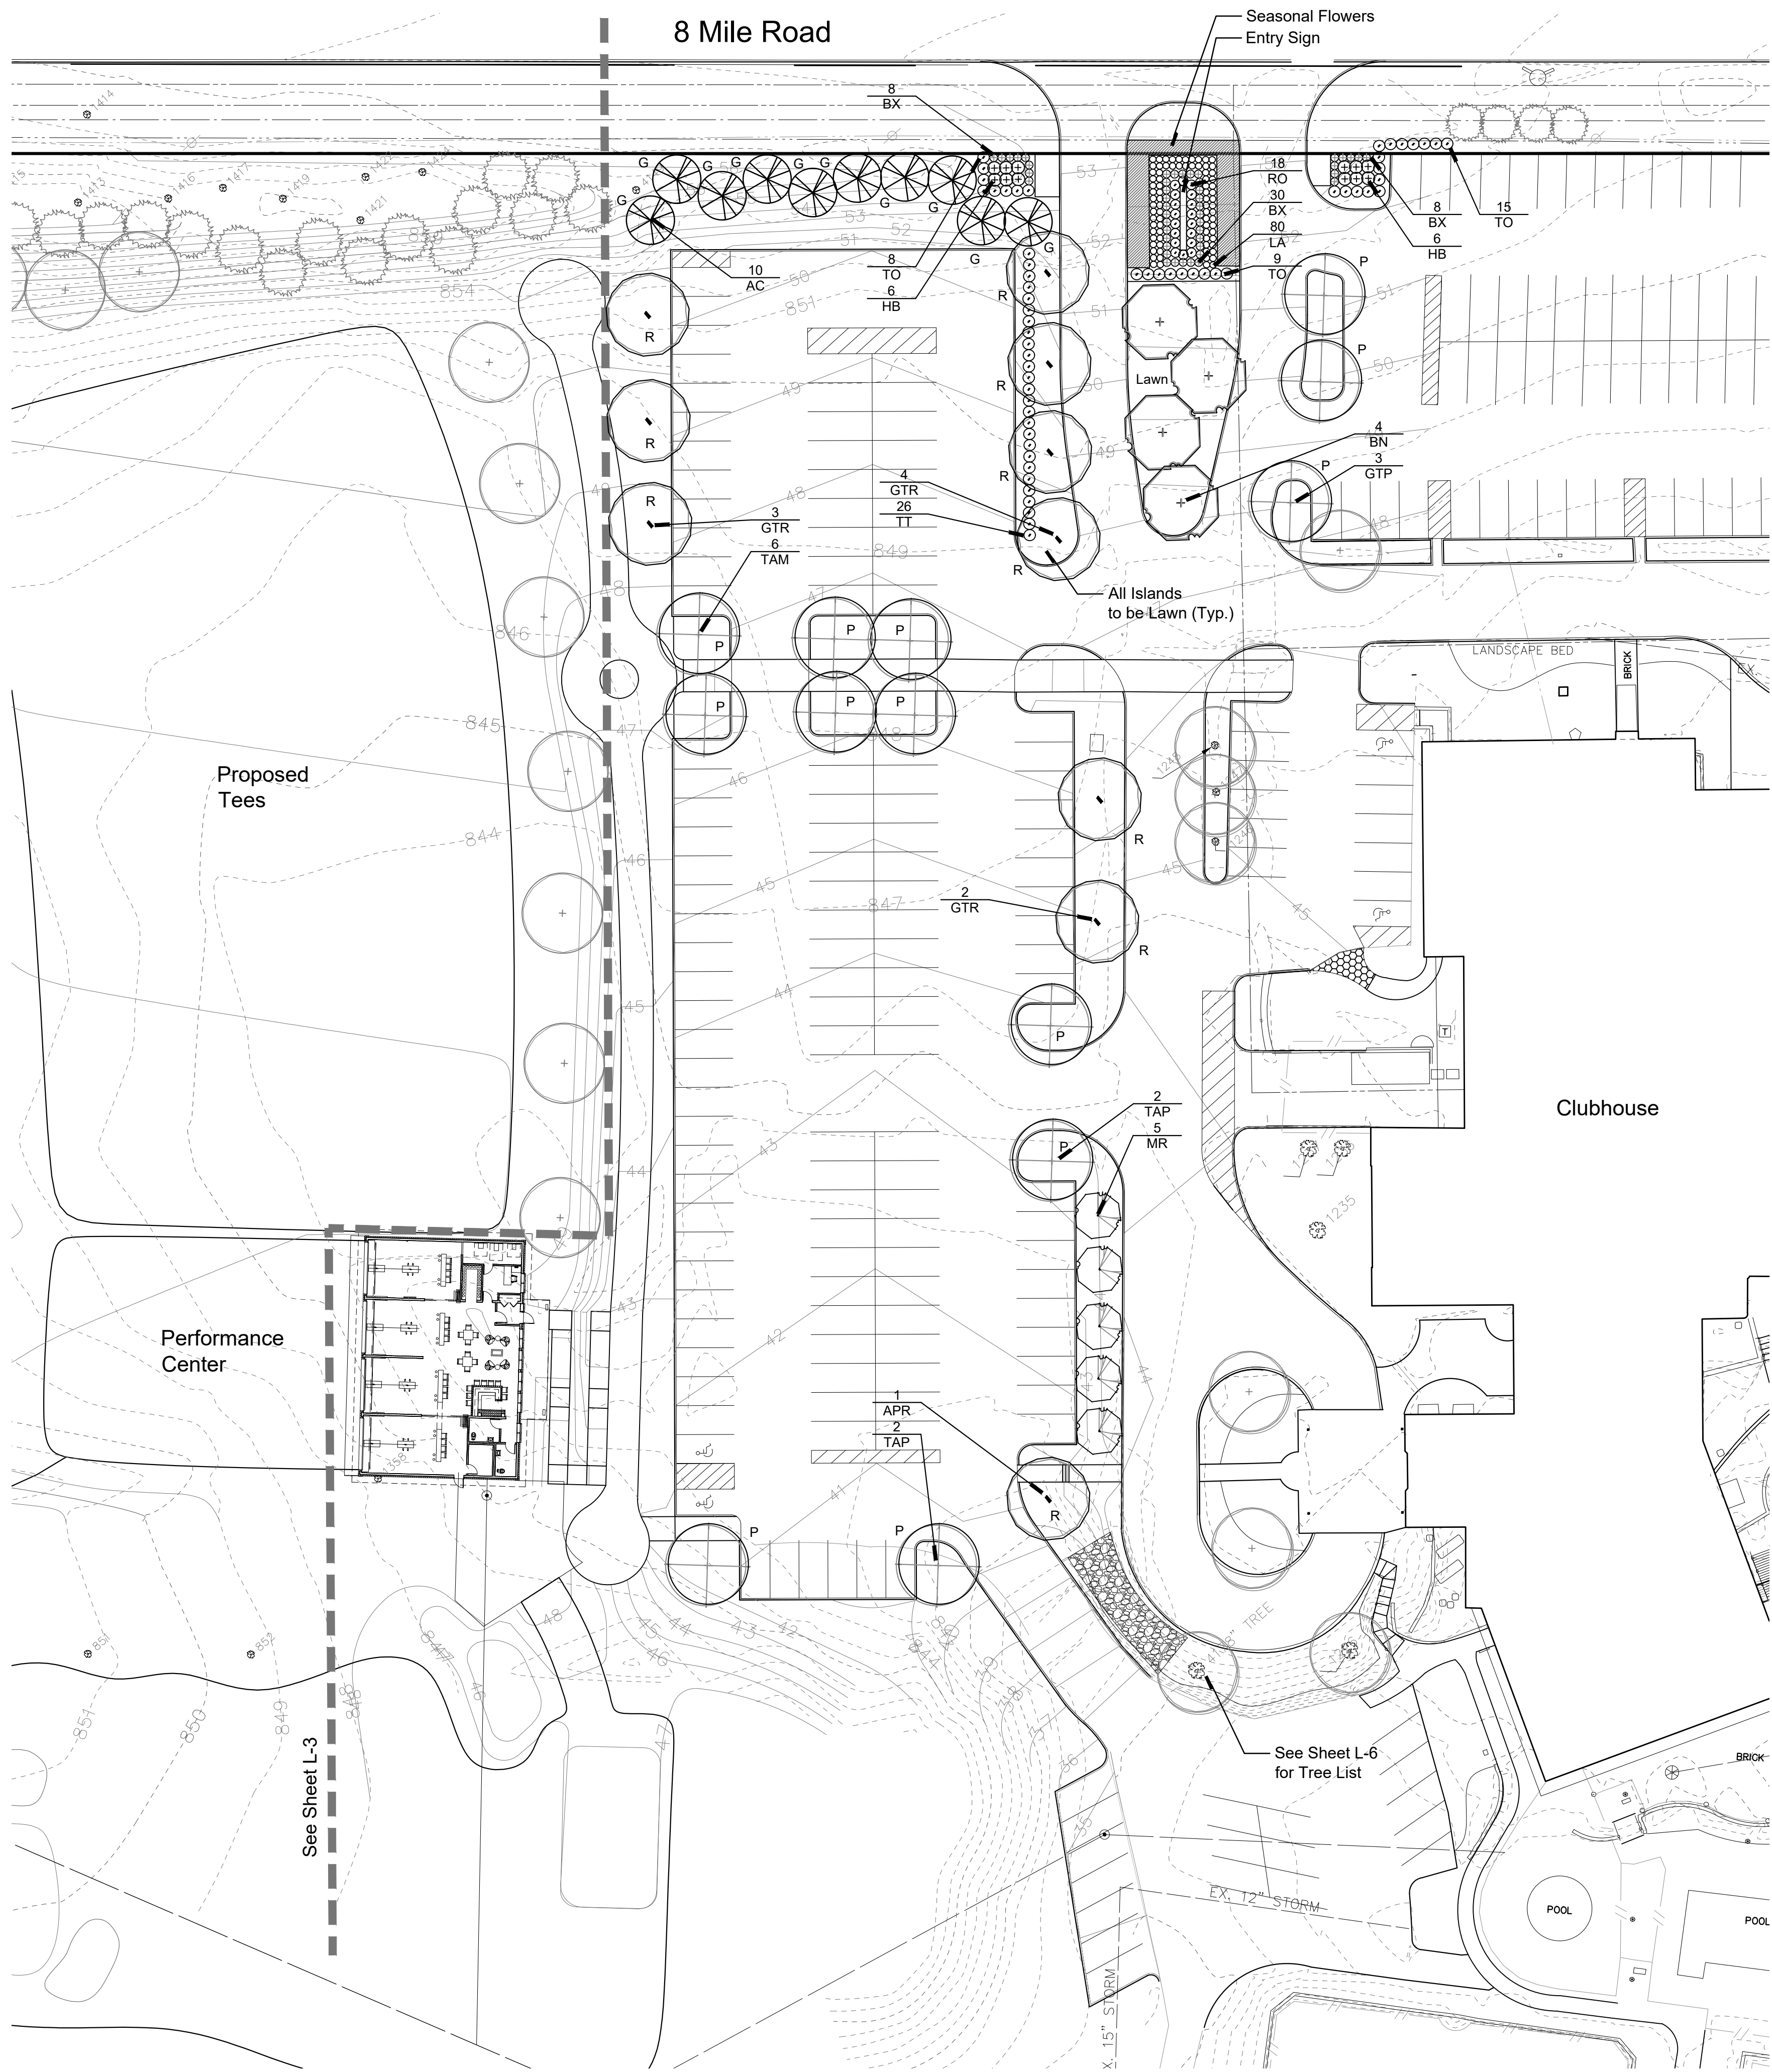


Landscape Summary - This Sheet

Street Trees	
8 Mile	
Street Frontage	354 l.f.
Trees Required	9 Trees (354' / 40')
Trees Provided	0 Trees*
Greenbelt	
8 Mile	
Greenbelt Length	354'
Trees Required	9 Trees (354' / 40')
Trees Provided	10 Trees
Shrubs Required	53 Shrubs (354' / 40') x 6
Trees Provided	108 Shrubs
Parking Lot Landscaping	
New Paved Area	37,491 s.f.
Trees Required	13 Trees (37,491 / 3,000)
Trees Provided	13 Trees
Woodland Replacement	
Replacement Required	334"
Maintenance Building Remaining Credits	62"
Total Replacement Required	396"
Replacement Trees Caliper Provided	398"
Sheet L-2	30"
Sheet L-3	368"
* Trees Cannot be Planted Due to Existing Underground Utilities.	

Plant List - This Sheet

sym.	qty.	botanical name	common name	caliper	spacing	root	height
Greenbelt							
AC	10	Abies concolor	White Fir		as shown	B&B	8'
BX	46	Buxus x. Green Velvet	Green Velvet Boxwood		as shown	cont.	24"
HB	12	Hydrangea p. LimeLight	LimeLight Hydrangea		as shown	cont.	30"
LA	80	Lavandula angustifolia 'Hidcote Blue'	Hidcote Blue Lavender		as shown	cont.	#2
RO	18	Rosa 'Coral Drift'	Coral Drift Rose		as shown	cont.	#3
TO	32	Thuja occidentalis 'Techny'	Techny Arborvitae		as shown	B&B	6', Clip to 5'
	10	Trees Provided					
	108	Shrubs Provided					
Parking Lot							
GTP	3	Gleditsia Triacanthos 'Skyline'	Skyline Honey Locust	3.0"	as shown	B&B	
TAP	10	Tilia americana 'McKsentry'	McKsentry Linden	3.0"	as shown	B&B	
	13	Trees Provided					
Woodland Replacement							
APR	1	Acer platanoides	Norway Maple	3.0"	as shown	B&B	
GTR	9	Gleditsia Triacanthos 'Skyline'	Skyline Honey Locust	3.0"	as shown	B&B	
	30.0	Replacement DBH Provided					
General Plantings							
BN	4	Betula nigra	Multi-Stem River Birch		as shown	B&B	14'
MR	5	Malus 'Red Barron'	Red Barron Crabapple	2.5"	as shown	cont.	
TT	26	Thuja occidentalis 'Techny'	Techny Arborvitae		as shown	B&B	6', Clip to 5'

Seal:

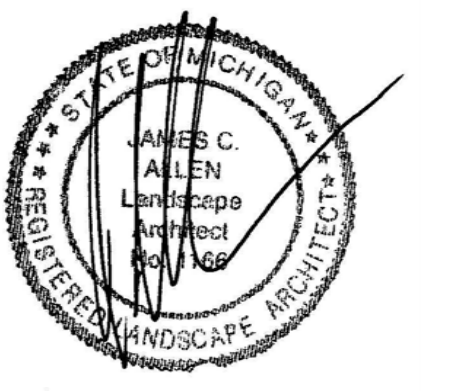

Title:

Entry Plan

Project:

Meadowbrook Country Club
 Northville Township, Michigan
 Driving Range and Entry

Prepared for:

Meadowbrook Country Club
 40941 West Eight Mile
 Northville, Michigan 48167

Revision:

Review
 SP Submittal

Issued:

June 9, 2022
 June 15, 2022

Job Number:


21-039

Drawn By:

jca

Checked By:


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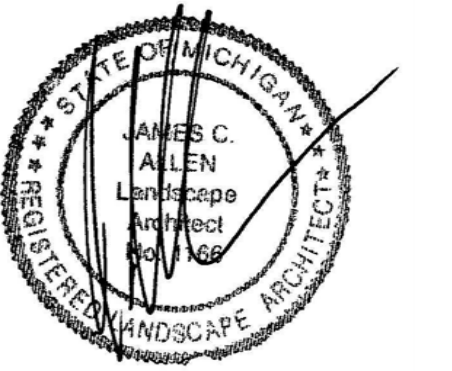
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L-2

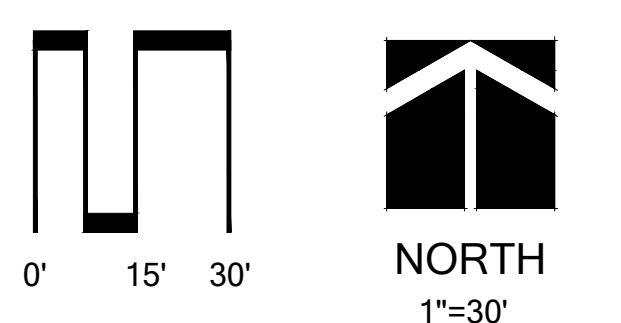



Seal: _____

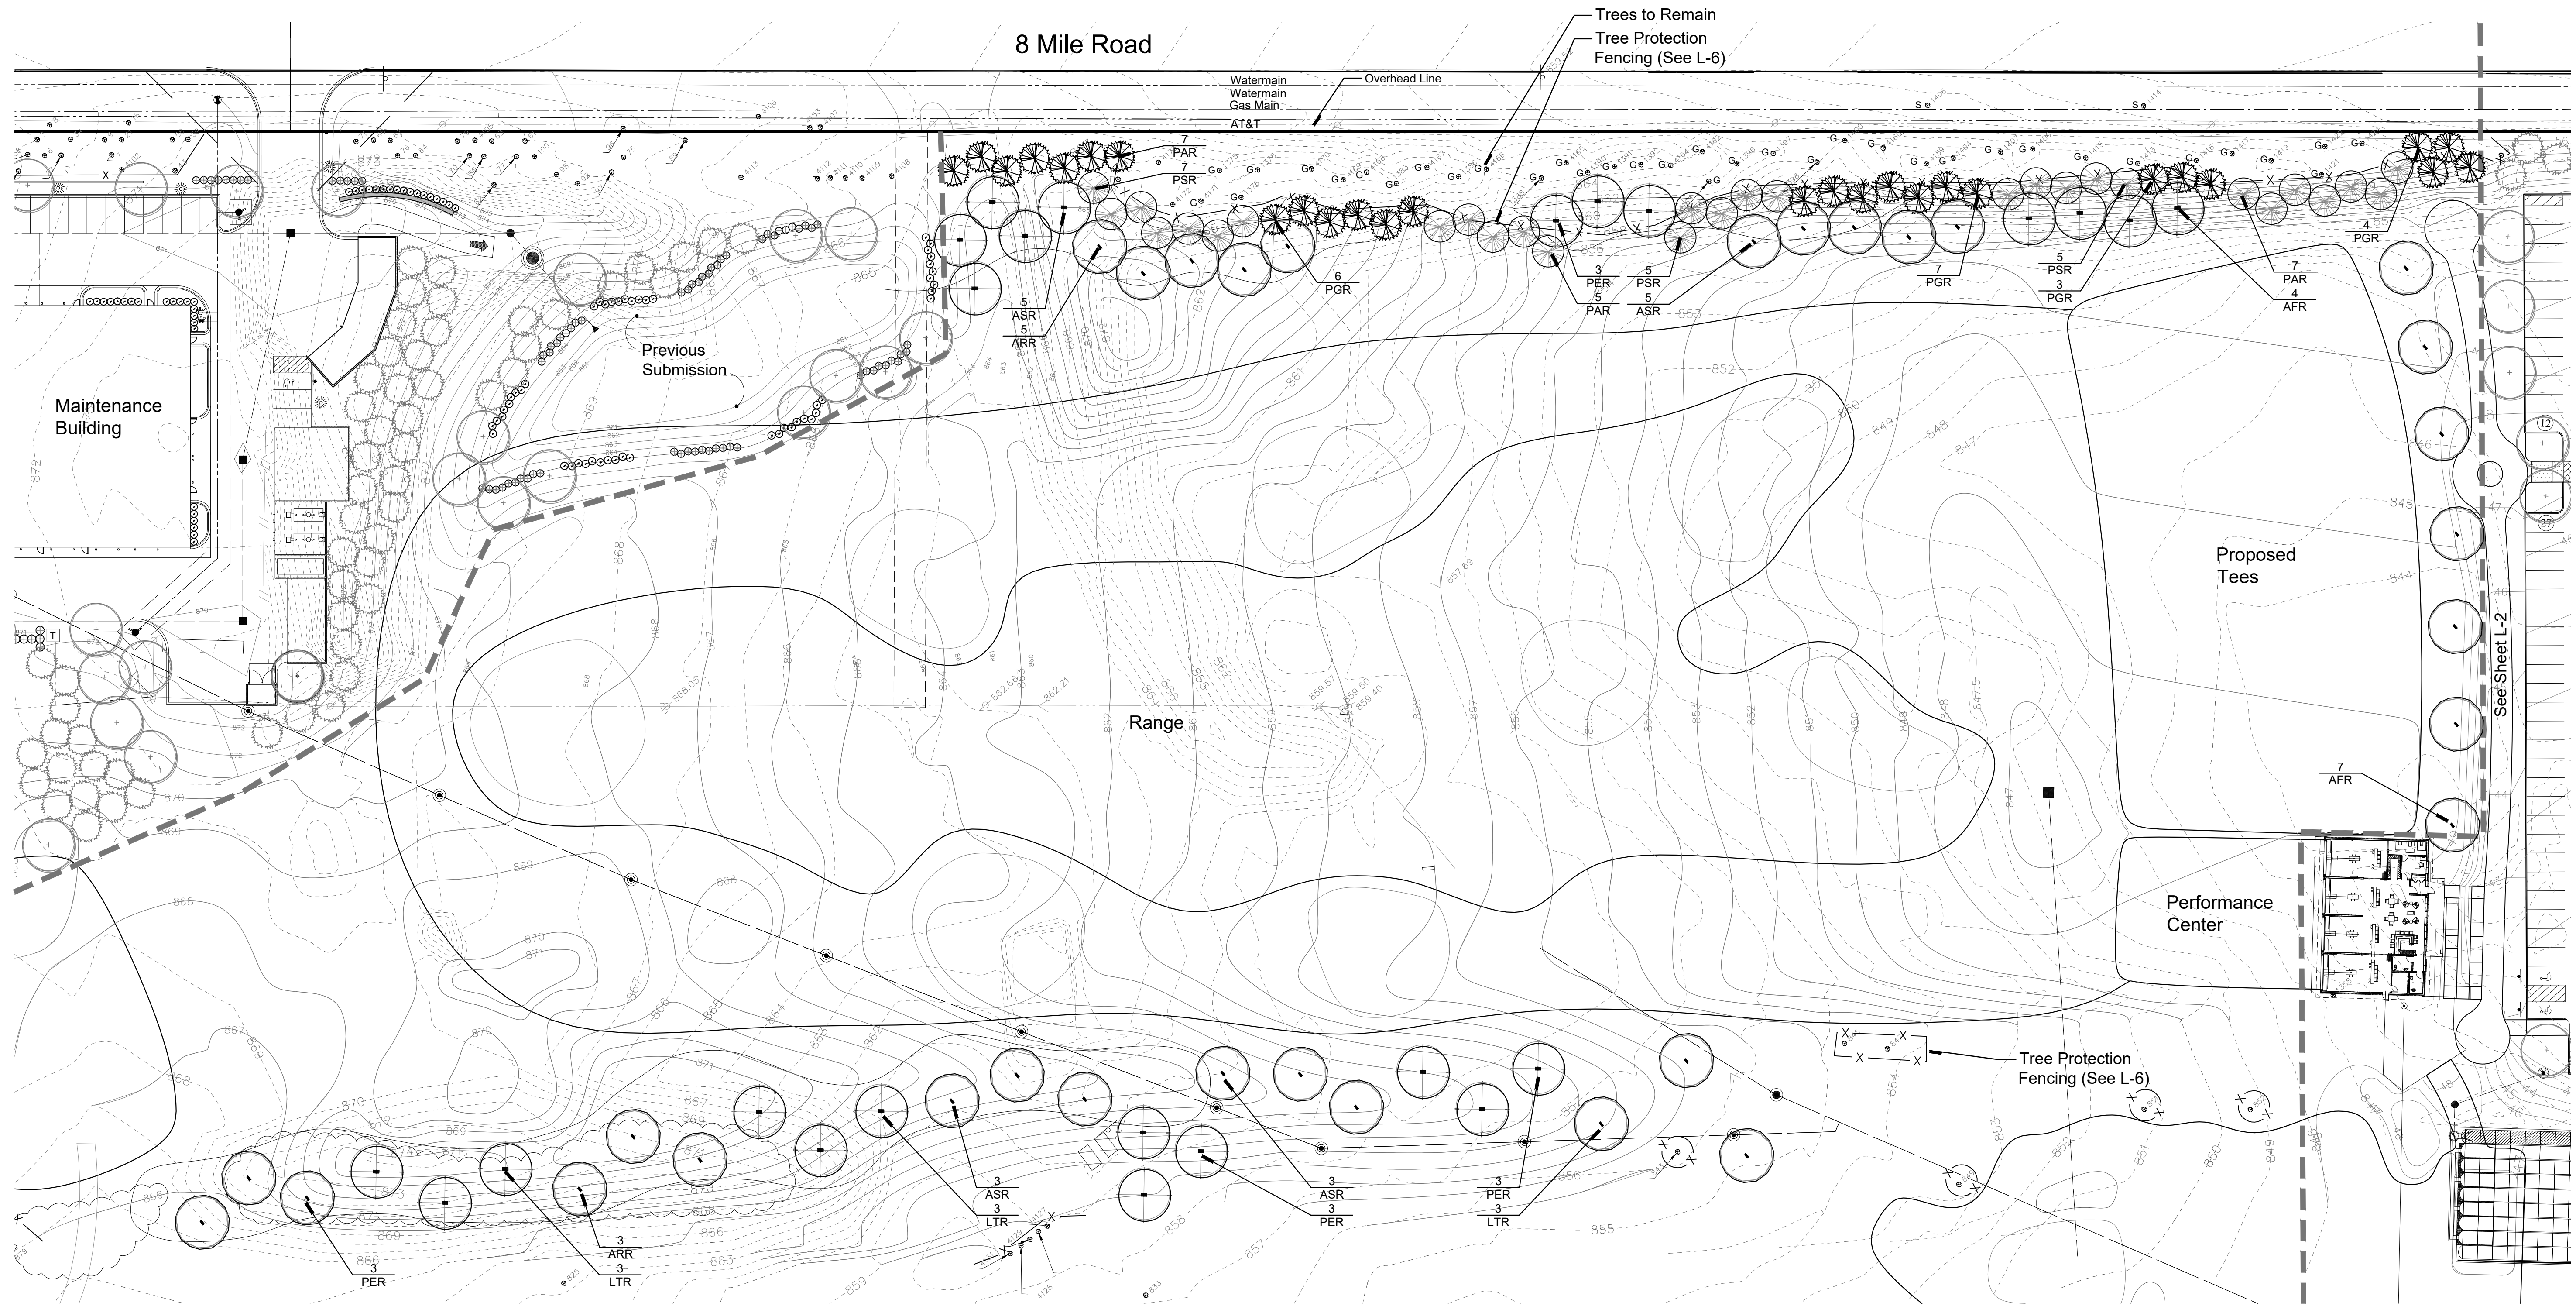

Title:
Landscape Plan


Project:
**Meadowbrook Country Club
 Northville Township, Michigan
 Driving Range and Entry**

Prepared for:
 Meadowbrook Country Club
 40941 West Eight Mile
 Northville, Michigan 48167

Revision: _____ Issued: _____
 Review SP Submittal June 9, 2022
 June 15, 2022

Job Number:
 21-039

Drawn By: _____ Checked By: _____
 jca jca

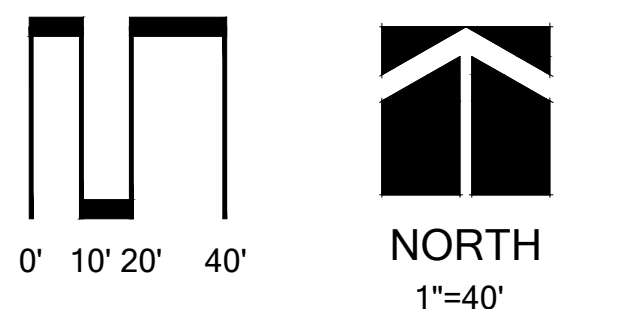

Sheet No. _____

Landscape Summary - This Sheet

Street Trees	
8 Mile	720 l.f.
"S" Street Frontage	18 Trees (720' / 40')
Trees Required	2 Trees (2 Existing)*
Trees Provided	
Greenbelt	
8 Mile	720'
"G" Greenbelt Length	18 Trees (720' / 40')
Trees Required	18 Trees (19 Existing)
Trees Provided	108 Shrubs (720' / 40') x 6
Shrubs Required	18 Trees (108 Shrubs / 6 = 18 Trees)
Trees Provided	(18 Existing)
Woodland Replacement	
Replacement Provided	368*

* Trees Cannot be Planted Due to Existing Underground Utilities.

Plant List - This Sheet

sym.	qty.	botanical name	common name	caliper	spacing	root	height	Replacement
Woodland Replacement								
AFR	11	Acer x. freemanii 'Autumn Blaze'	Autumn Blaze Maple	3.0"	as shown	B&B	33.0	
ARR	8	Acer rubrum 'October Glory'	October Glory Red Maple	3.0"	as shown	B&B	24.0	
ASR	16	Acer saccharum 'Green Mountain'	Green Mountain Sugar Maple	3.0"	as shown	B&B	48.0	
LTR	9	Liriodendron tulipifera	Tulip Tree	3.0"	as shown	B&B	27.0	
PAR	19	Picea abies	Norway Spruce		as shown	B&B	67.9	
PER	12	Platanus x acerifolia 'Exclamation'	Exclamation London Planetree	3.0"	as shown	B&B	36.0	
PGR	20	Picea glauca 'Densata'	Black Hills Spruce		as shown	B&B	71.4	
PSR	17	Pinus strobus	White Pine		as shown	B&B	60.7	
368.0 Replacement DBH Provided								



ISSUED FOR: _____ DATE: _____

1 PERMIT BID SET 03/18/22

3 SP REVIEW 06/15/22

GENERAL NOTES

1. ALL MASONRY AND MORTAR JOINTS TO BE INTEGRALLY FIELD APPLIED WITH WATER REPELLANT SEALER.
2. SEE STRUCTURAL DRAWINGS FOR RECOMMENDED MASONRY CONTROL JOINTS. FINAL LOCATIONS TO BE APPROVED BY ARCHITECT.



2 WEST ELEVATION
 SCALE: 1/4" = 1'-0"



1 EAST ELEVATION
 SCALE: 1/4" = 1'-0"

PROJECT


PERFORMANCE CENTER

MEADOWBROOK COUNTRY CLUB
 40941 EIGHT MILE ROAD
 NORTHVILLE MI 48167

SHEET

EXTERIOR ELEVATIONS

STAMP

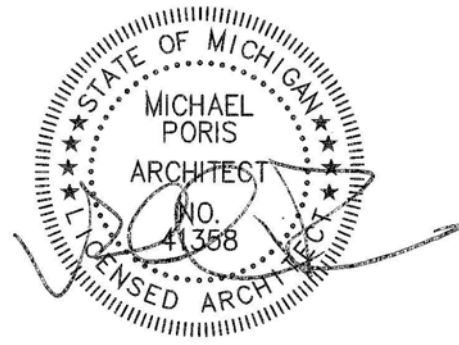

SCALE

1/4" = 1'-0"

PROJECT NUMBER


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SHEET NUMBER


A-200

GENERAL NOTES

1. ALL MASONRY AND MORTAR JOINTS TO BE INTEGRALLY FIELD APPLIED WITH WATER REPELLANT SEALER.
2. SEE STRUCTURAL DRAWINGS FOR RECOMMENDED MASONRY CONTROL JOINTS. FINAL LOCATIONS TO BE APPROVED BY ARCHITECT.

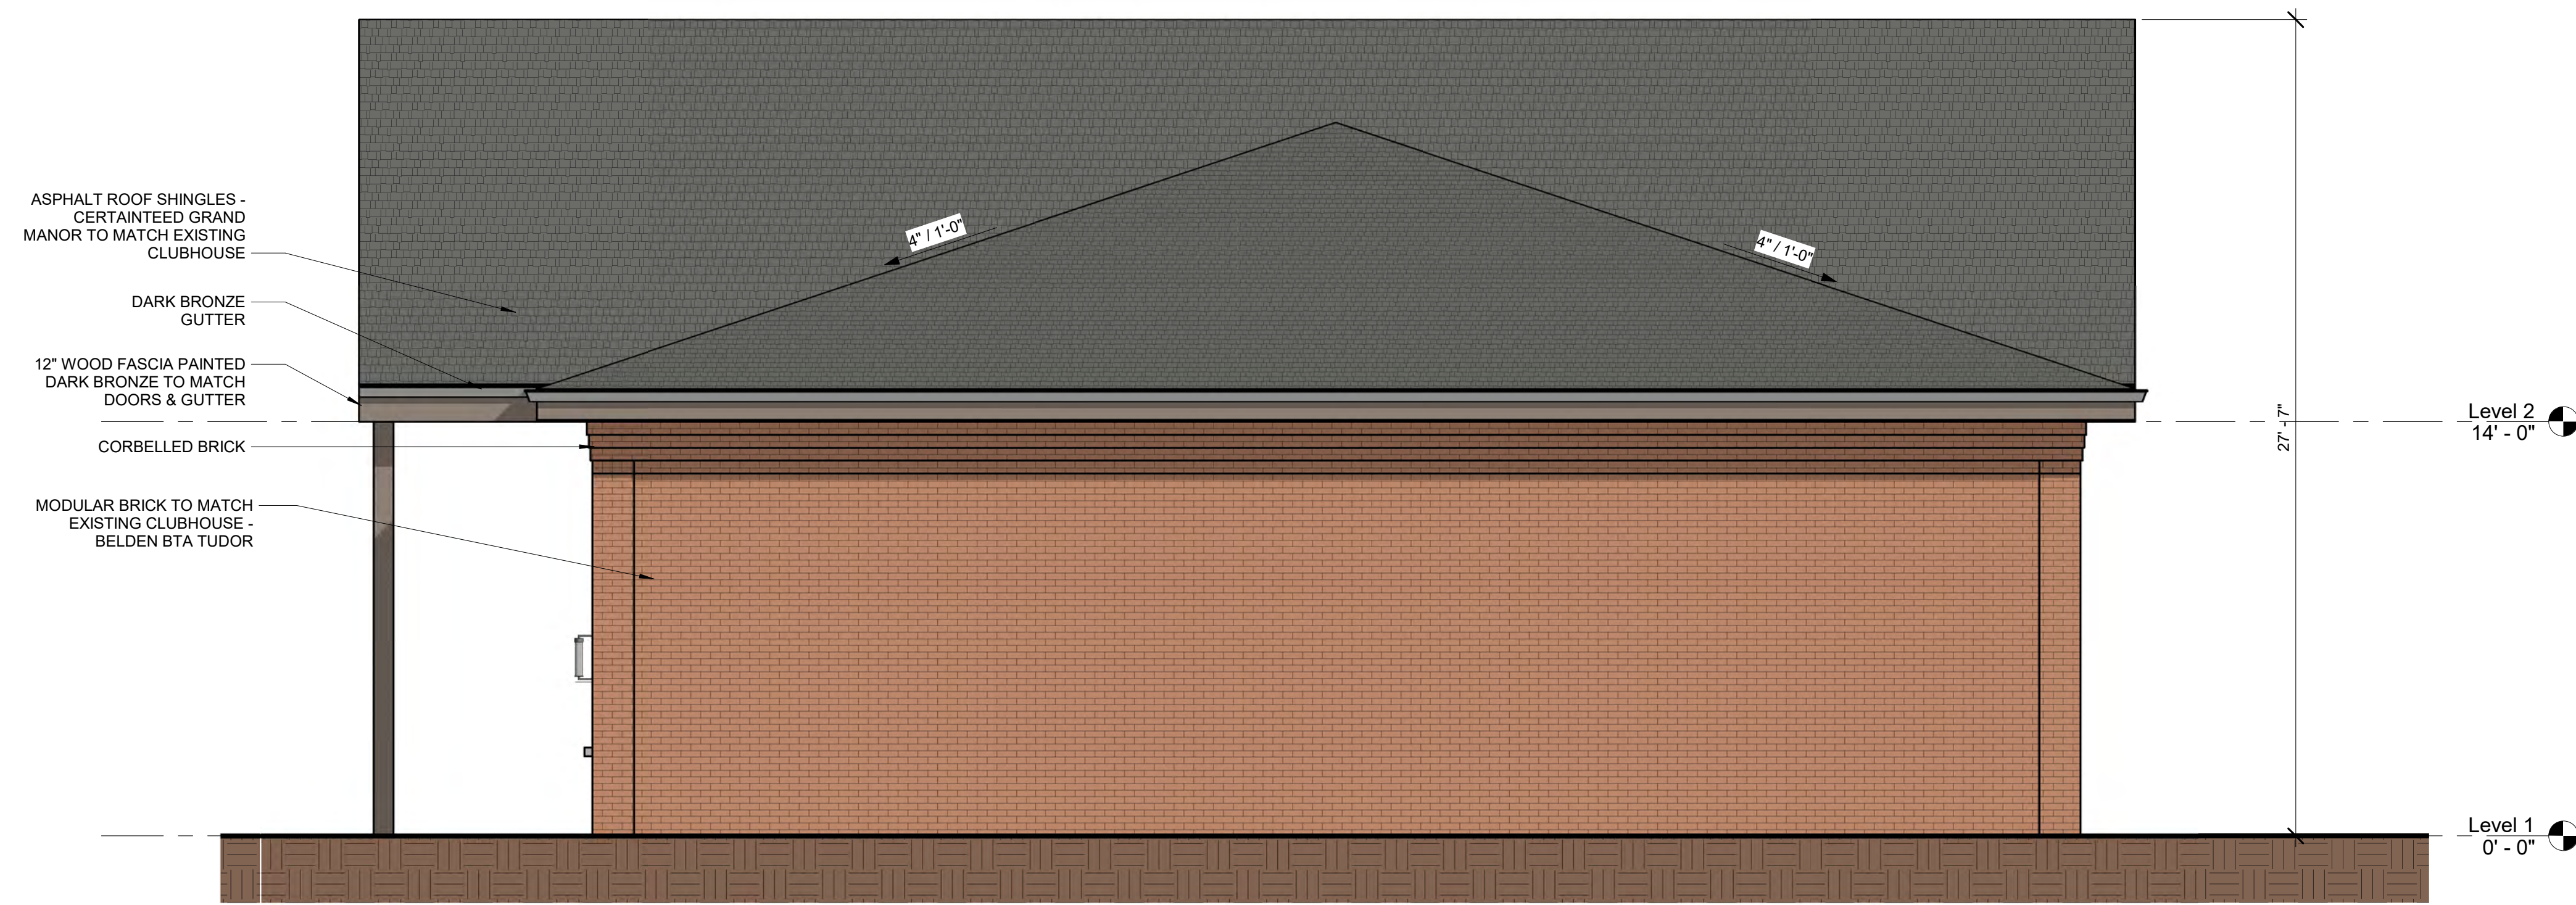

2 ELEVATION NORTH
 SCALE: 1/4" = 1'-0"

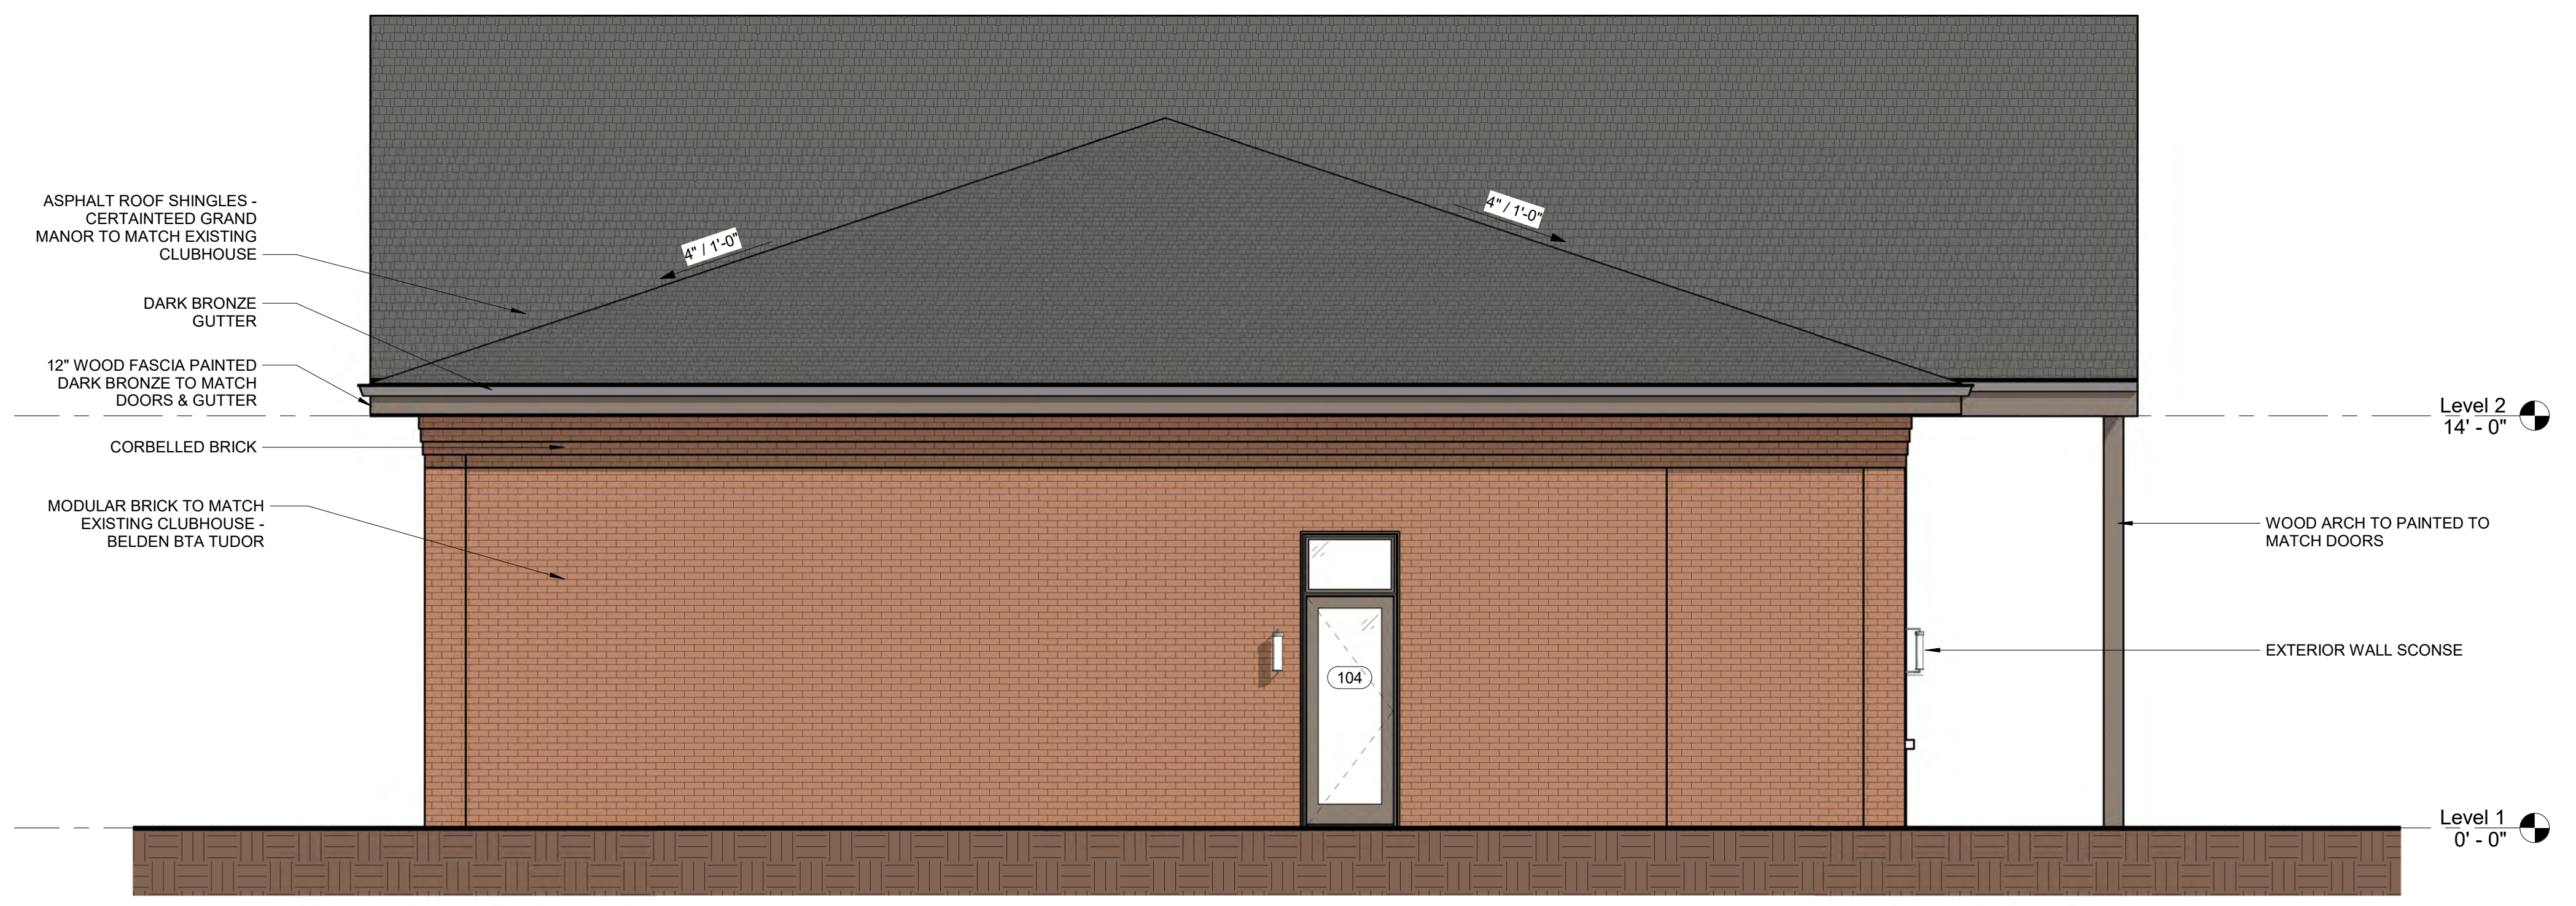

1 ELEVATION SOUTH
 SCALE: 1/4" = 1'-0"

PROJECT


PERFORMANCE CENTER

MEADOWBROOK
 COUNTRY CLUB
 40941 EIGHT MILE ROAD
 NORTHVILLE MI 48167

SHEET

EXTERIOR ELEVATIONS

STAMP

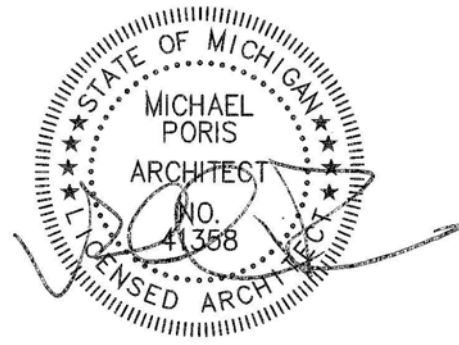

SCALE

1/4" = 1'-0"

PROJECT NUMBER

2106.00

SHEET NUMBER

A-201